A CUSTOM RESIDENCE

SCOPE OF WORK:

NEW CONSTRUCTION... CREATING A SINGLE FAMILY (R-1) RESIDENTIAL DWELLING...

AREA

FIRST FLOOR - 1048 Sq. Ft. FRONT PORCH - 84 Sq. Ft. REAR DECK - 192 Sq. Ft.

INDEX TO DRAWINGS:

A100 - COVER SHEET

A101 - FIRST FLOOR PLAN

A102 - ELEVATIONS

A103 - FLOOR FRAMING PLAN

A104 - CROSS SECTION

A105 - ROOF PLAN & ROOF FRAME

A106 - ELECTRICAL & PLUMBING PLAN

A107 - FOUNDATION PLAN



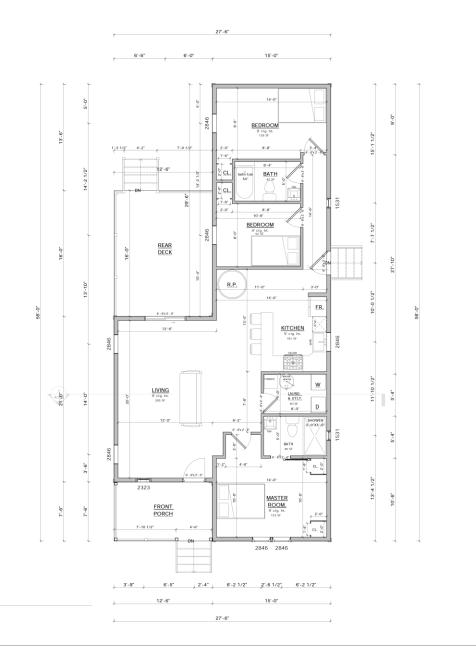
CLIENT:

PROJECT : SINGLE FAMILY (R-1) RESIDENTIAL DWELLING

DESIGNER: mister.prodesign@gmail.com

DATE: AUGUST 18, 2020

	R SHEET
Project Number	01
Date	08/20/2020
Drawn By	
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1 FIRST FLOOR 1/4" = 1'-0" CONTRACTOR TO VERIFY ALL DIMENSIONS & EXISTING SITE CONDITIONS PRIOR TO CONSTRUCTION.

ALL EXTERNAL WALLS ARE 6", WHILE INTERNAL WALLS ARE 4".

DOOR & WINDOW SIZES ARE GIVEN IN INCHES IN WIDTH & HEIGHT RESPECTIVELY.

DOOR EXAMPLE: 6'-8" X 3'-0" IS 6'-8" TALL BY 3'-0" WIDE. WINDOW EXAMPLE: 2846 IS 2'-4" WIDE BY 3'-10" TALL.

CONTRACTOR SHALL VERIFY ALL INTERIOR FINISHES, FLOOR COVERINGS, AND TRIM SIZES & CONFIGURATIONS WITH OWNER PRIOR TO CONSTRUCTION.

IT IS THE SOLE RESPONSIBILITY OF THE CONTRACTOR TO VERIFY CLEARANCES OF THE ITEMS MENTIONED ABOVE PRIOR TO CONSTRUCTION.

REFER TO MANUFACTURERS SPECS FOR ROUGH OPENING DIMENSIONS, FOR DOORS AND WINDOWS.

ALL BEAM SIZES TO BE VERIFIED BY STRUCTURAL ENGINEER.

CONTRACTOR SHALL MAKE ALL NECESSARY MODIFICATIONS DURING CONSTRUCTION PROCESS TO COMPLY WITH I.R.C. (INTERNATIONAL RESIDENTIAL CODE), LATEST EDITION, OR APPLICABLE CODES AT SITE.

AREA SUMMARY

HEATED AREA

FIRST FLOOR - 1048 Sq. Ft.

UNHEATED AREA

FRONT PORCH - 84 Sq. Ft.

REAR DECK - 192 Sq. Ft.

FIRST FLOOR PLAN

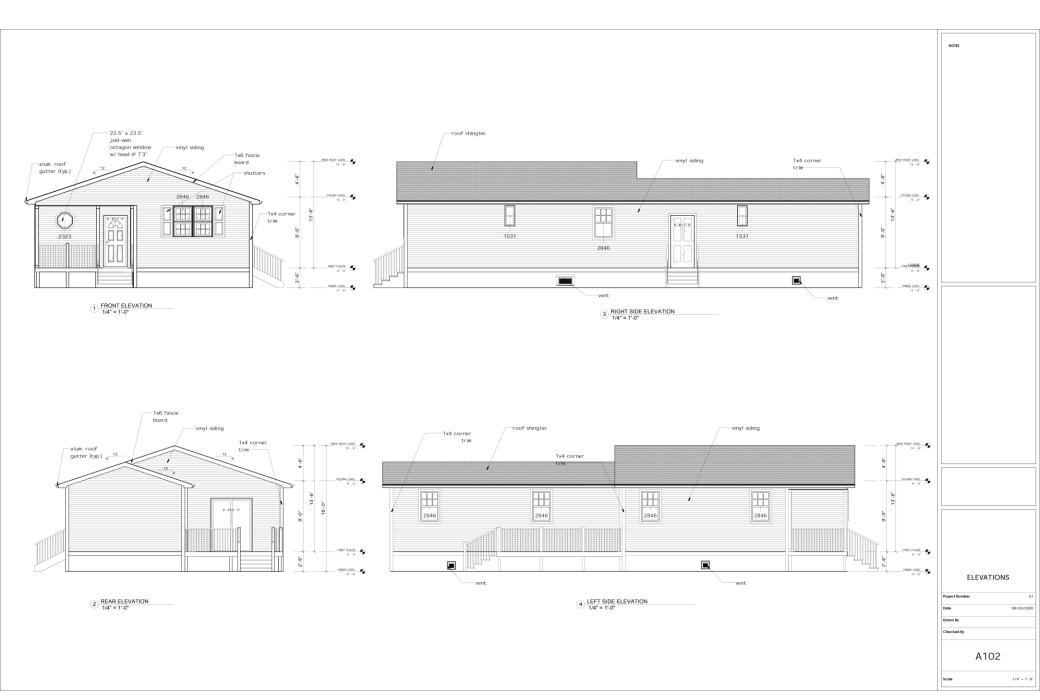
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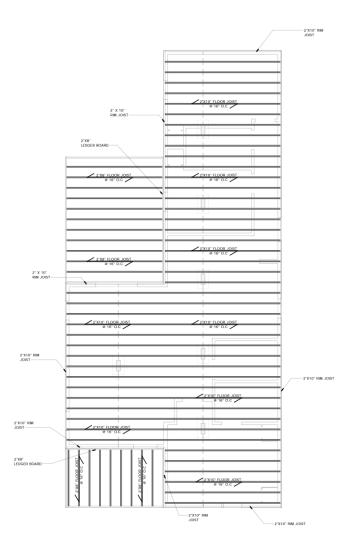
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1 FIRST FLOOR FRAMING PLAN

NOTE: SPAN TABLES ARE PROVIDED FOR USE IF STICK FRAMING IS DESIRED BY OWNER/ BUILDER.

FLOOR JOIST SPANS

FLOOR JOIST SPANS FOR SOUTHERN PINE SPECIES (RESIDENTIAL LIVING AREAS, LIVE LOAD = 40psf, L/ = \(\triangle 360\))
DEAD LOAD = 10psf

SIZE	SPACING (INCHES)	VISUALLY GRADED #2 SOUTHERN PINE (MAXIMUM FLOOR JOIST SPANS) (FT IN.)
12.0	12.0	10-9
2 x 6	16.0	9-9
	19.2	9-2
	24.0	8-6
2 x 8	12.0	14-2
	16.0	12-10
	19.2	12-1
	24.0	11-0
2 x 10	12.0	18-0
	16.0	16-1
	19.2	14-8
	24.0	13-1
	12.0	21-9
	16.0	18-10
2 x 12	19.2	17-2
	24.0	15-5

NOTES: For additional species, grades, and notes, refer to the International Residential Code. The above tables are based on the 2003 edition, table R502.3.1(2).

CEILING JOIST SPANS

CEILING JOIST SPANS FOR SOUTHERN PINE SPECIES (UNINHABITABLE ATTICS WITHOUT STORAGE, LIVE LOAD = 10psf, L/ =\(\(\triangle 240\)) DEAD LOAD = 5psf

***IF HABITABLE ATTIC SPACE OF STORAGE IS DESIRED, REFER TO THE INTERNATIONAL RESIDENTIAL CODE SDAN TABLE

SIZE	SPACING (INCHES)	VISUALLY GRADED #2 SOUTHERN PINE (MAXIMUM CELLING JOIST SPANS) (FT NL.)
2 x 4	12.0	12-5
	16.0	11-3
	19.2	10-7
	24.0	9-10
2 x 6	12.0	19-6
	16.0	17-8
	19.2	16-8
	24.0	15-6
2 x 8	12.0	25-8
	16.0	23-4
	19.2	21-11
	24.0	20-1
2 x 10	12.0	XXXXX
	16.0	XXXXX
2 1 10	19.2	XXXXX
	24.0	23-11

RAFTER SPANS

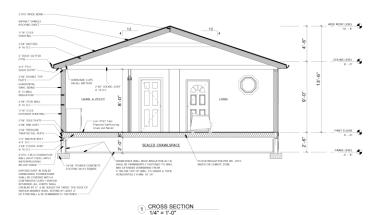
RAFTER SPANS FOR SOUTHERN PINE SPECIES

SIZE	SPACING (INCHES)	VISUALLY GRADED #2 SOUTHERN PINE (MAXMUM RAFTER SPANS BETWEEN BRACH (FT IN.)
	12.0	8-7
2 x 4	16.0	7-10
	19.2	7-4
	24.0	6-10
	12.0	13-6
2 x 6	16.0	12-3
	19.2	11-5
	24.0	10-2
	12.0	17-10
[16.0	16-2
2 x 8	19.2	14-9
	24.0	13-2
	12.0	22-3
2 x 10	16.0	19-3
2 x 10	19.2	17-7
	24.0	15-9
	12.0	XXXXX
2 x 12	16.0	22-7
	19.2	20-7
	24.0	18-5

FLOOR FRAMING PLAN

Project Number 08/20/2020

A105



		Door Scheo	tule	
Mark	Count	Operation	Height	Width
1	1	SingleSwin gRight	6" - 8"	3" - 0"
2	5		6' - 8"	2" - 6"
3	1		6" - 8"	2" - 6"
4	1		6" - 8"	3" - 0"
5	1	SLIDING	6' - 8"	5' - 0"

-VERIFY/COORDINATE ALL DOOR SIZES WITH CHOSEN MANUFACTURER.
-DIMENSIONS GIVEN ARE FOR ACTUAL DOOR LEAF DIMENSIONS, COORDINATE ROLLGH OPPININGS

-DOOR JAMBS SHALL BE 4" OFF ADJACENT WALL ON HINGE SIDE, U.N.O. 3" IS
PERMITTED WITHIN RESIDENTIAL UNITS

- CLOSET DOORS ARE CENTERED ON CLOSET WIDTH, U.N.O.

PROVIDE FLOOR STOPS ONLY WHERE IT WILL NOT PRESENT A TRIPPING HAZARD.
USE APPROPRIATE DOOR STOP BASED ON FLOOR TYPE AND UNDERCUT.

-COORDINATE ENTRY DOOR HARDWARE WITH SECURITY CONTRACTOR

- SATIN CHROME FINISH

		Window Sch	edule	
Mark	Count	Operation	Width	Height
1	1		1' - 11 1/2"	1' - 11 1/2"
2	2		2' - 4"	3' - 10"
3	5		2" - 4"	3' - 10"
4	2	DoublePanel Horizontal	1' - 3"	2' - 7"
5	1		2" - 0"	1' - 2"
6	1		1' - 0"	1' - 0"
7	1		1' - 0"	1' - 0"
9	1		1' - 0"	1' - 0"

WINDOW NOTES:

*VERIFY/COORDINATE ALL WINDOW SIZES WITH SELECTED MANUFACTURER.

*ROUGH OPENING SIZES AS PER MANUFACTURER SPECIFICATIONS.

VERIFY/COORDINATE ALL ROUGH OPENINGS WITH WINDOW MANUFACTURER.
*ALL WINDOWS TO BE INSULATED LOW E; WINDOWS TO HAVE U-VALUE OF .35 OR BETTER

*OWNER TO VERIFY SIZE/TYPE/STYLE/COLOR OF ALL WINDOWS

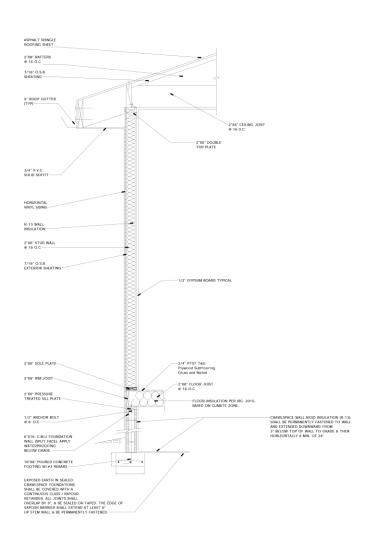
*VERIFY ALL NEW WINDOW/DOOR ASSEMBLIES ARE TAPED/FLASHED/CAULKED

@ ALL HEADS/SILLS/JAMBS PER MANUFACTURER SPECIFICATIONS (TYP.)

* ALIGN ALL WINDOW & DOOR HEADERS HORIZONTALLY PER FLOOR U.N.O.
* WINDOWS MULLED AS PER ELEVATION; MULLION THICKNESS MAY VARY PER MANUFACTURER

 WINDOWS MULLED AS PER ELEVATION; MULLION THICKNESS MAY "COORDINATE WINDOW OPERATION WITH BUILDING ELEVATIONS"

Roor	m Schedule	
Name	Level	Area
BEDROOM 2	FIRST FLOOR	129 SF
BEDROOM 1	FIRST	91 SF
BATH 2	FIRST	42 SF
LAUND. & UTILITY	FIRST FLOOR	40 SF
MASTER ROOM	FIRST FLOOR	153 SF
KITCHEN	FIRST	181 SF
BATH 1	FIRST	40 SF
LIVING	FIRST	295 SF



CROSS SECTION & WALL

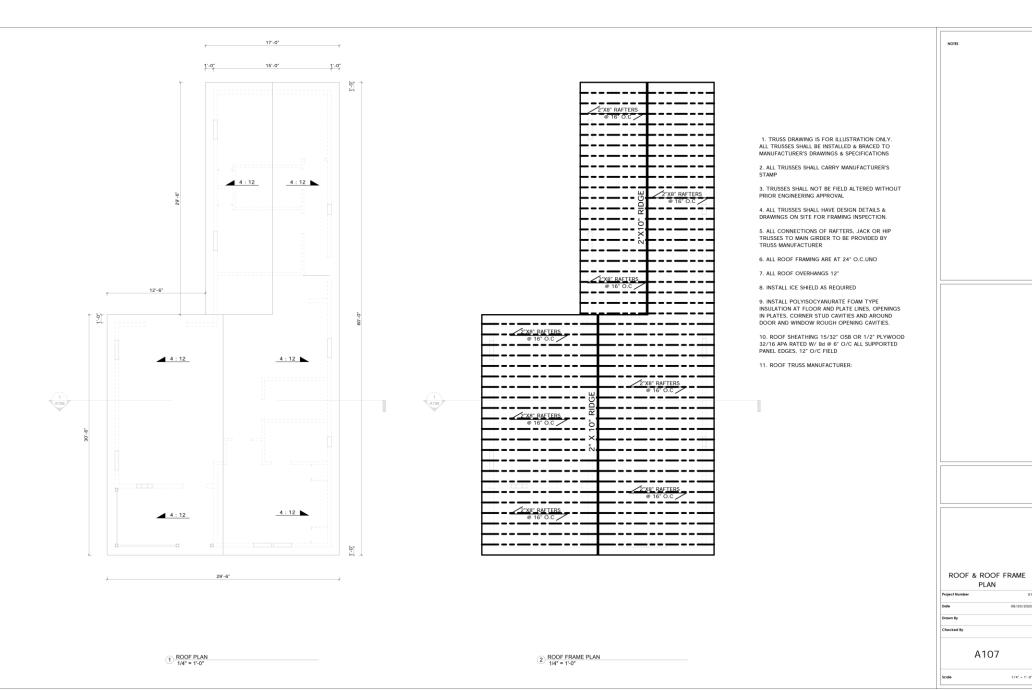
DETAIL

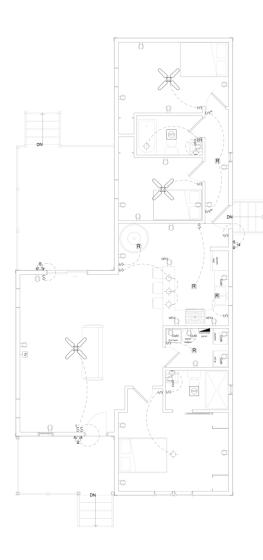
A106

08/20/2020

Project Number

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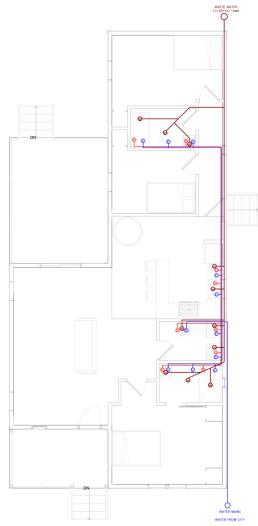
ELECTRICAL CONTRACTOR TO VERIFY ALL EXISTING SITE CONDITIONS & MAKE ANY NECESSARY ADJUSTMENTS.

SMALLEST WIRE SIZE TO BE 12-2.

ALL WORK SHALL COMPLY WITH THE NATIONAL ELECTRIC CODE & ANY OTHER APPLICABLE REGULATIONS OR CODES, AT THE SITE.

ALL SMOKE DETECTORS TO BE HARD-WIRED TOGETHER WITH BATTERY BACKUP.

CONTRACTOR TO LOCATE PHONE, CABLE, ETC. AS PER OWNER'S SPECIFICATIONS.



LEGEND	LEGEND	
COLD WATER LINE		
HOT WATER LINE		
WASTE WATER LINE		
COLD WATER ACCESS	0	
HOT WATER ACCESS	0	
WASTE WATER ACCESS	0	

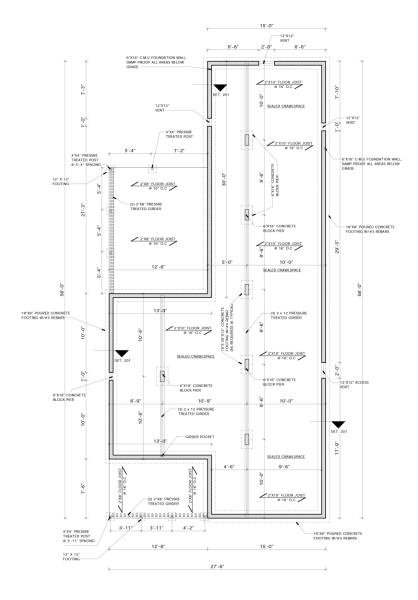
2 FIRST FLOOR ELECTRICAL 1/4" = 1'-0"

1 FIRST FLOOR PLUMBING 1/4" = 1'-0"

ELECTRICAL & PLUMBING PLAN

08/20/2020

A109



FOUNDATION NOTES:

- 1. OWNER SHALL HAVE ALL FOOTING SIZES VERIFIED BY A LICENSED STRUCTURAL ENGINEER, BASED ON SOILS ANALYSIS AT SITE, PRIOR TO CONSTRUCTION.
- 2. FOUNDATION SHALL COMPLY WITH ALL APPLICABLE CODES AT SITE.
- 3. CONTRACTOR SHALL VERIFY ALL SITE CONDITIONS WITH FOUNDATION PLAN AND MAKE NECESSARY ADJUSTMENTS.
- 4. CONTRACTOR SHALL VERIFY ALL DIMENSIONS AT SITE.
- 5. CONTRACTOR SHALL BE RESPONSIBLE FOR PROVIDING PROPER DRAINAGE AT SITE.
- 6. GLUE ALL STUR-DI-FLOR PLYWOOD TO FLOOR FRAMING AND NAIL SECURELY W/ RING-SHANK NAILS.
- ALL FOUNDATION DETAILS ARE TYPICAL.
 SOME VARIATIONS MAY OCCUR. CONTRACTOR TO MAKE NECESSARY ADJUSTMENTS AT SITE.
- 8. ALL CONCRETE SLABS TO BE 4" THICK (3000 psi MIN.), REINFORCED W/ 6"x6" - 10/10 W.M.
- PROVIDE DOUBLE JOISTS UNDER ALL WALLS RUNNING PARALLEL TO FLOOR JOISTS.

3/4" PTST T&G Plywood Subflooring Glues and Nailed 2"X10" FLOOR JOIST @ 16 O.C INSULATION 2"X10" RIM JOIST 2" X 6" TREATED SILL PLATE TERMITE SHIELD 6" CONC. BLK., FILLED W/ CONC. CRAWLSPACE WALL RIGID INSULATION (R-13) SHALL BE PERMANENTLY FASTENED TO WALL AND EXTENDED DOWNWARD FROM 3" BELOW TOP OF WALL TO GRADE & THEN HORIZONTALLY A MIN. OF 24" FIN. GRADE, SLOPE AWAY FROM BLDG. INSUL. BD., SEE SPECS. MAS. JT. REINF. @ 16" O.C., VERT. REINFORCING, AS REQ'D BY CODE UN-DISTURBED SOIL LINE 3-#4 BARS, CONT., W/ #4 TIES @36" O.C. (OR AS REQ'D BY LOCAL CODE.)

DET. 201

1 FOUNDATION PLAN

FOUNDATION PLAN

08/20/2020

A111